


5 7 12,02,2007	155UE	DATE	BY	DESCRIPTION
3 FEB. 02, 2007 JP ISSUED FOR BUILDING PERMIT	1	NOV. 27. 2006	JP	PRELIMINARY DESIGN No. 1
J TLD, OZ, ZOOT OT TO		DEC. 15. 2006	JP	ISSUED FOR TRUSS & JOIST
4 MAR. 27. 2007 JP ISSUED FOR CONSTRUCTION	3	FEB.02,2001	JP	ISSUED FOR BUILDING PERMIT
	4	MAR. 27. 2007	JP	ISSUED FOR CONSTRUCTION

HILLSIDE **ENGINEERING** SERVICES LTD.

LAND PLANNING ~ ENGINEERING ~ WASTEWATER SYSTEMS
PERMITTING ~ STRUCTURAL ~ CIVIL ~ CADD ~ DESIGN
COMMERCIAL ~ INDUSTRIAL ~ RESIDENTIAL

54 NANAIMO AVENUE EAST, PENTICTON, BC. V2A 1L9 PHONE (250) 490.4155 ~ FAX (250) 490.4156

F	lavell-Seminara Res	oldence	
	Main Floor Plan	η	
50 BLACKTA	. PLACE, 090Y009, BC., (REGAL RIDGE		
SCALE: 1/4" = 1'-0"	DRAWIN	DRAWING No. 5157-05	
DRAWN BY: JP	AUG. 02, 2006	19d11	
LOCATION : LOT 8, PLAN	KAP78794, DL 2709, SDYD		

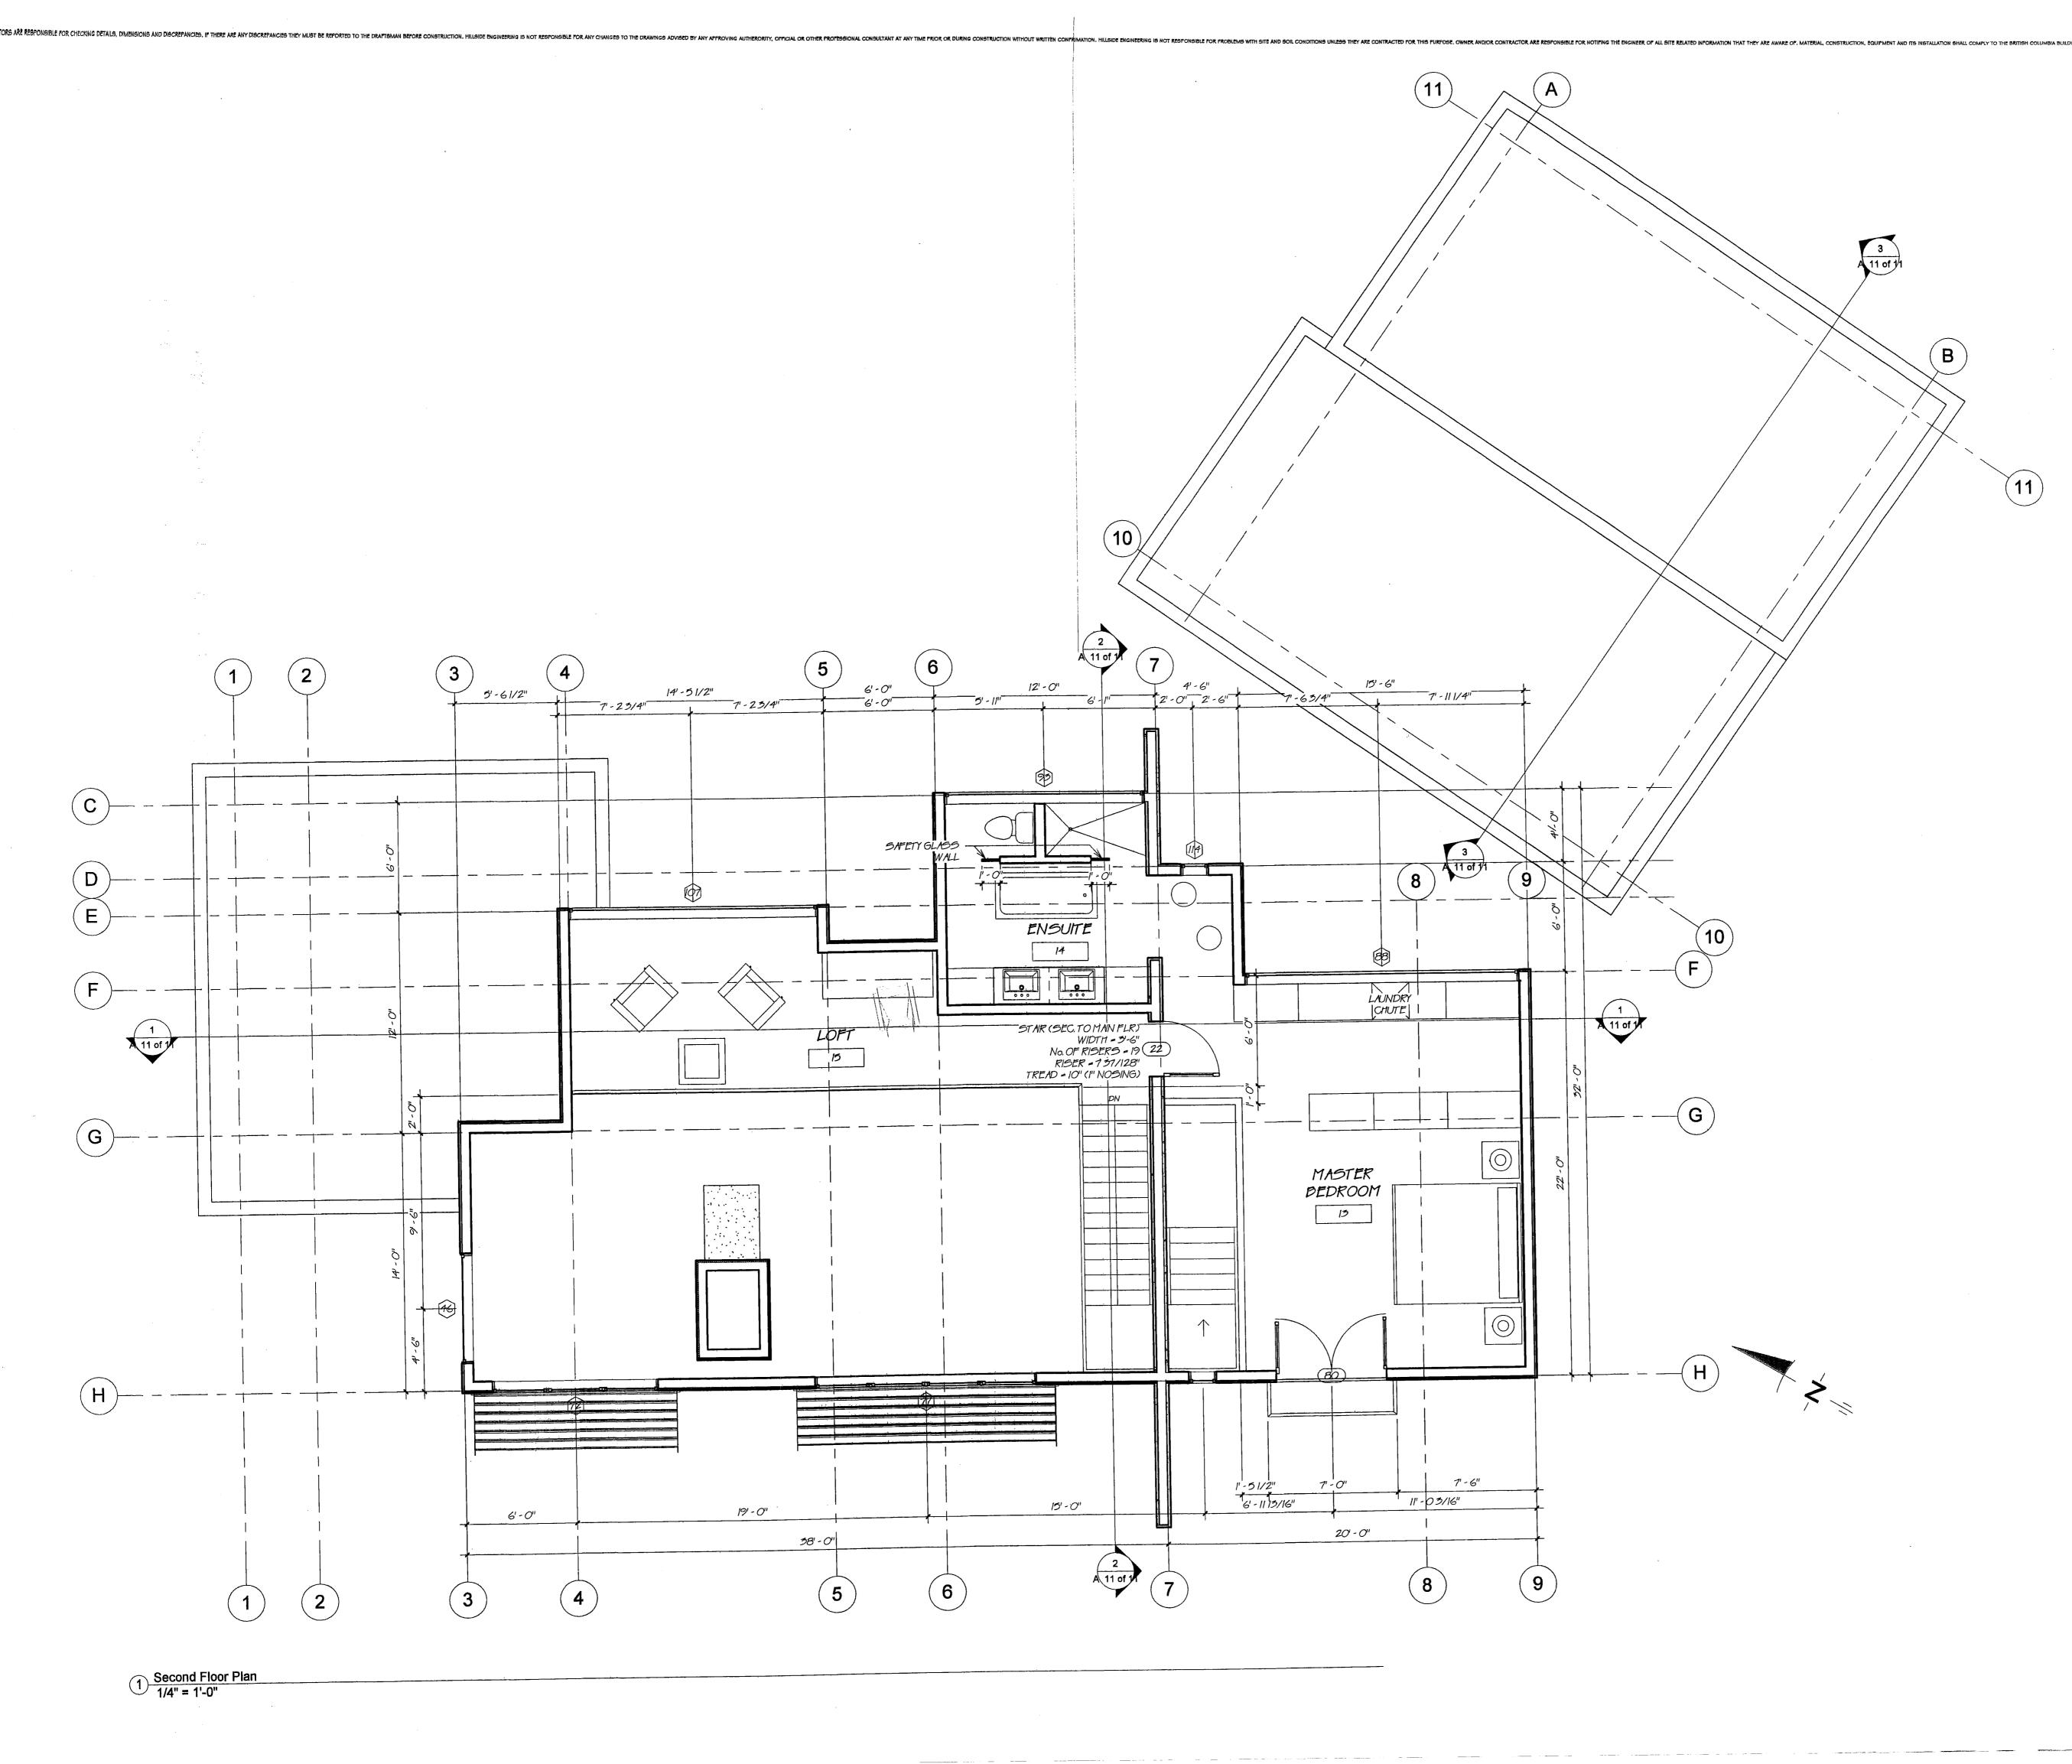

1 NOV. 27. 2006 JP PRELIMINARY DESIGN No. 2 DEC. 15. 2006 JP ISSUED FOR TRUSS & JOIS 3 FEB. 02. 2007 JP ISSUED FOR BUILDING PERI ISSUED FOR CONSTRUCTION	N No I
3 FEB. 02, 2001 JP ISSUED FOR BUILDING PERI	14 140, 1
3 FEB. 02, 2007 JP ISSUED FOR BUILDING PERI	\$ JOIST
1 4 MAR 27, 2007 JP ISSUED FOR CONSTRUCTION	3 PERMI
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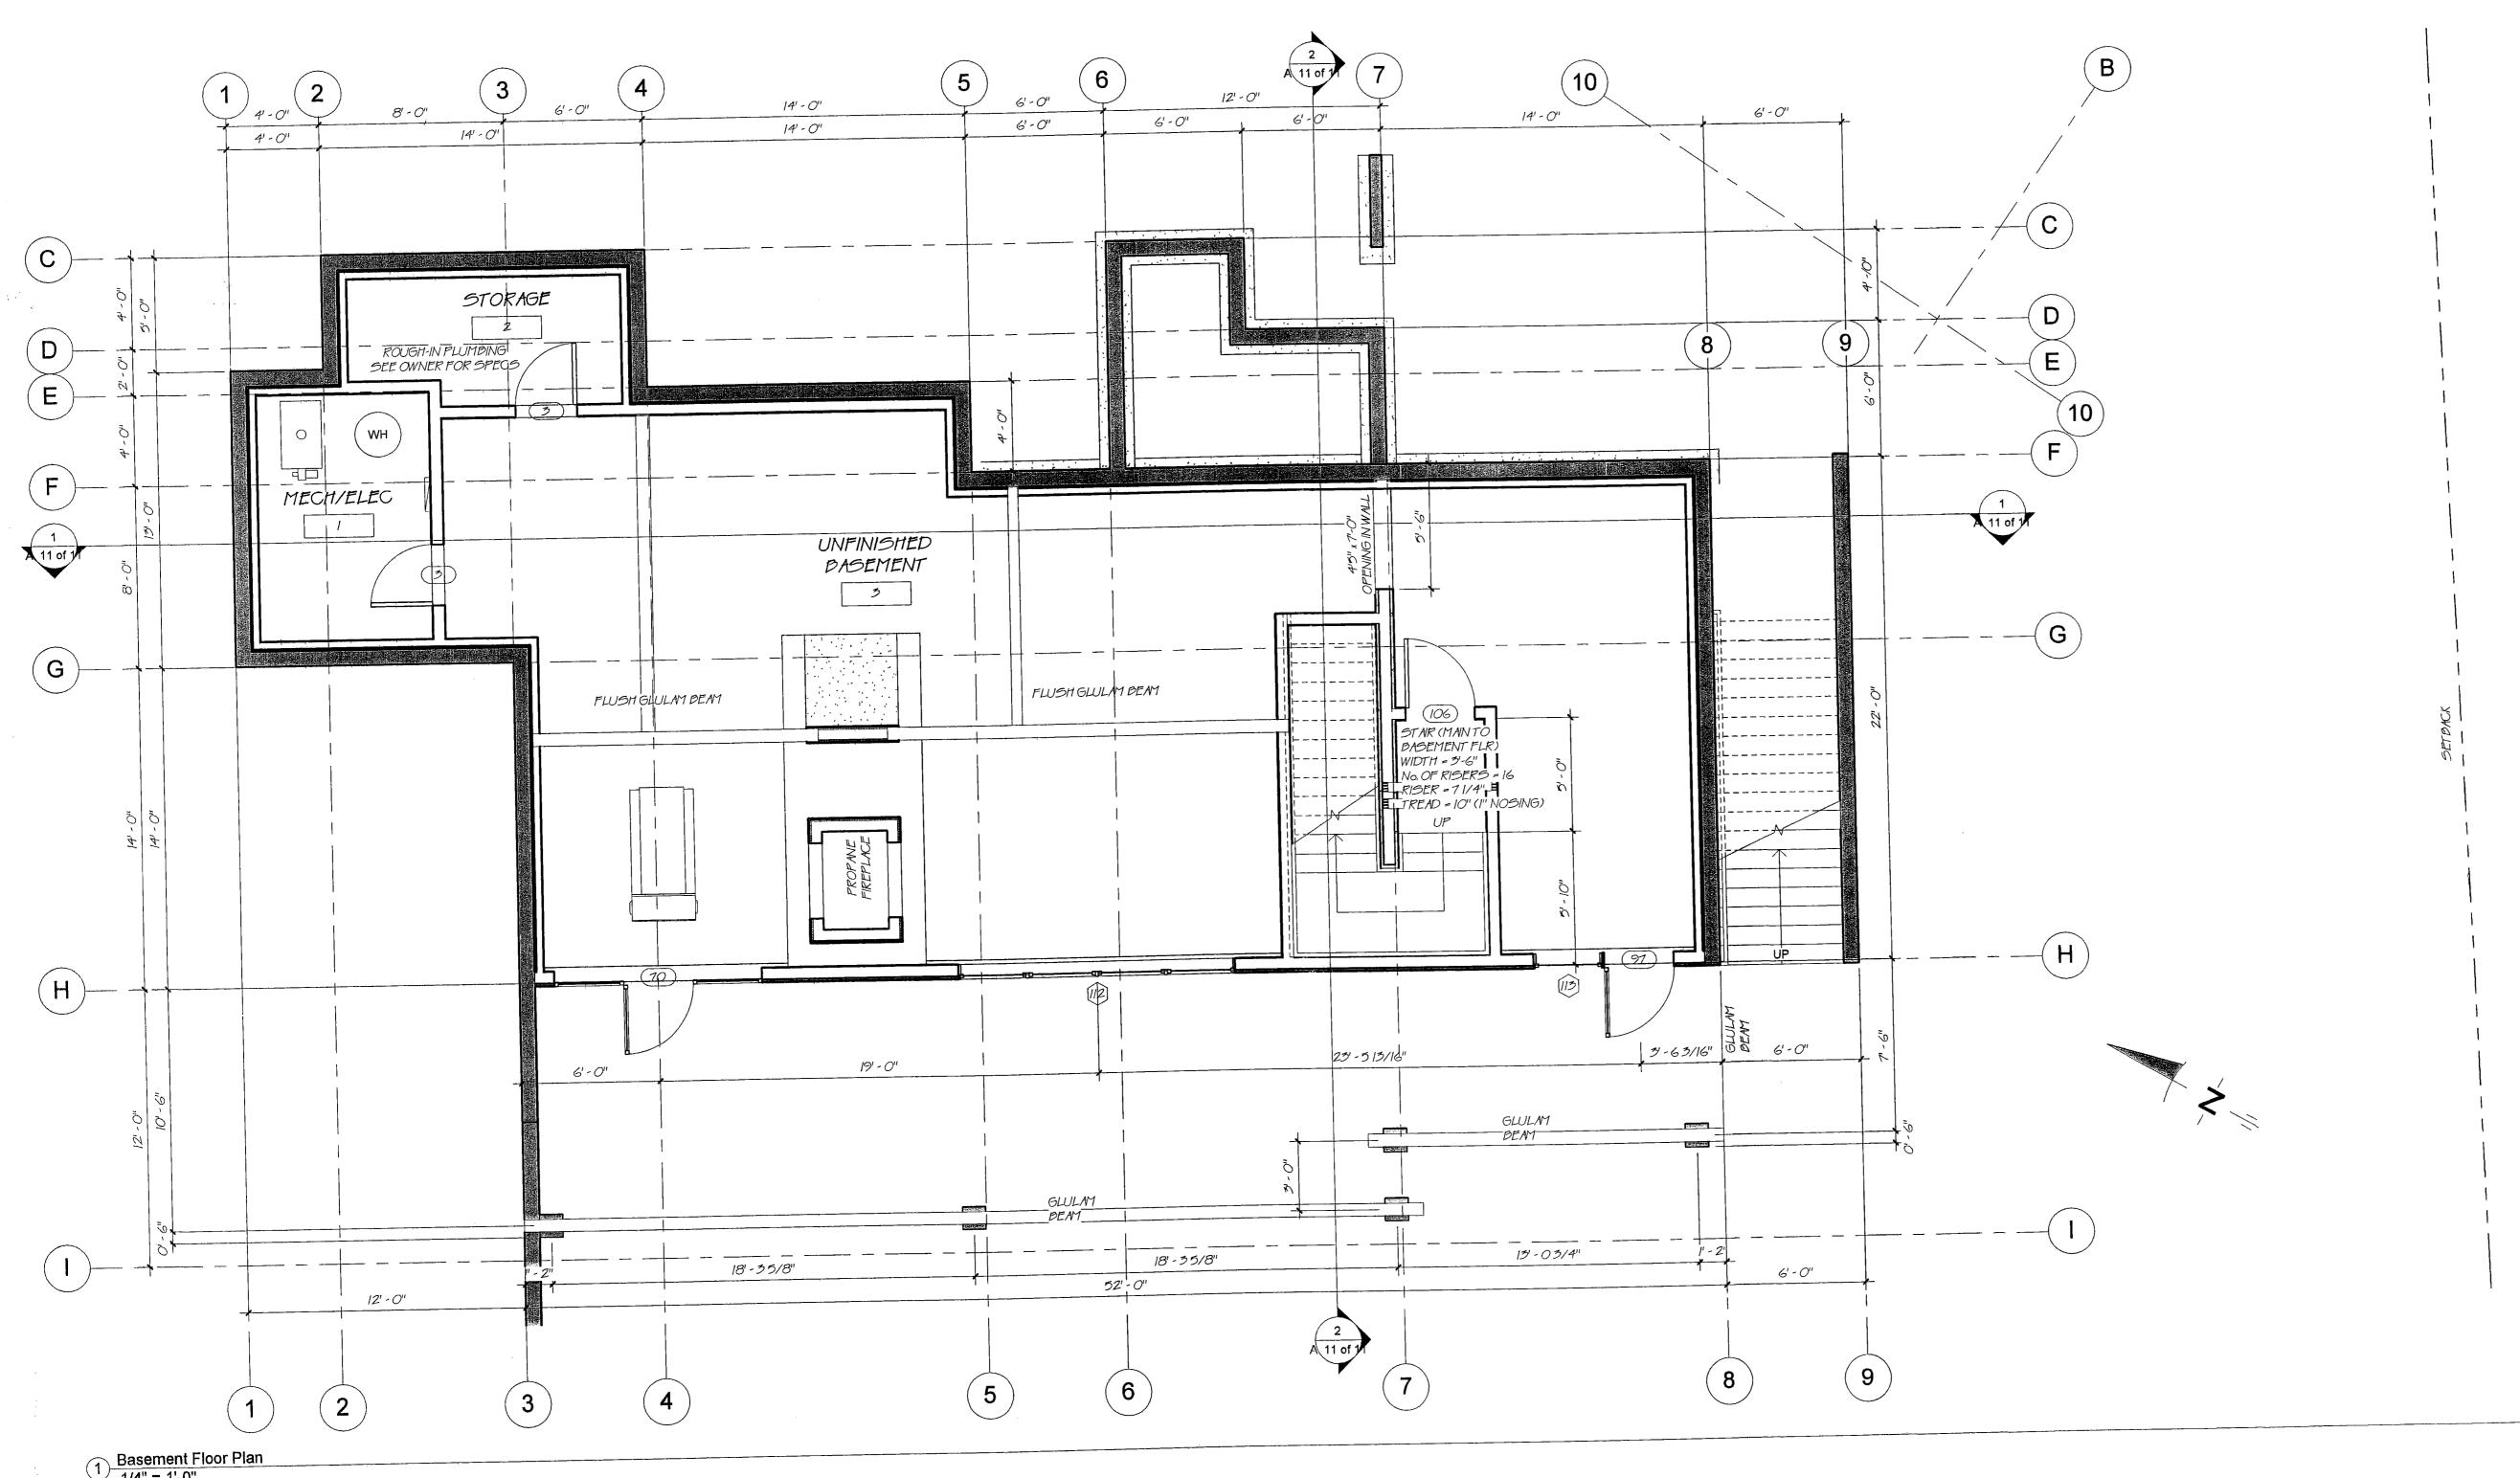
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54 NANAIMO AVENUE EAST, PENTICTON, BC. V2A 1L9 PHONE (250) 490.4155 ~ FAX (250) 490.4156

	Second Fi	Second Floor Plan		
50 BLACKT	AL PLACE, OSOY	. PLACE, 050Y005, BC., (REGAL RIDGE		
SCALE: 1/4" = 1'-0		DRAWING No. 5157-05		
DRAWN BY : JP	AUG. 02, 200	%	A80111	
LOCATION: LOT 8, PLI	W KAP78794, DL	2109,5	DYD	

Flavell-Seminara Residence



		Door Schedu			<u> </u>
Type Mark	Door Schedule	Width	Meight	Level	Count
					7
3	Single-Flush: 32" x 80"	2'-8"	6-8"		/
19	Sliding-Closed: 48" x 80"	4'-0"	6-8"	Main Floor Plan	
22	Single-Glass 1: 36" x 84"	3-0"	7'-0"	Second Floor Plan	<u> </u>
52	Single-Glass 4: 36" x 84"	3-0"	7'-0"	Main Floor Plan	2
58	Single-Gloss 4: 48" x 84"	4'-0"	7'-0"	Main Floor Plan	1
60	Double-Panel 2: 48" x 84"	4-0"	7'-0"	Main Floor Plan	1
67	Overhead-Sectional: 10' x 9'	10' - 0"	9-0"	Main Floor Plan	1
70	Triple-Gloss 1 (No Trim): 108" x 84"	9-0"	7'-0"		2
	Sliding-4 panel (No Trim): 72" x 84"	6-0"	7'-0"	Main Floor Plan	1
75	Double-Glass 1 (No Trlm): 72" x 84"	6'-0"	7'-0"		2
80		2' - 8"	6'-8"	Main Floor Plan	2
93	Single-Pocket: 32" x 80"	3-0"	7'-0"		2
97	Single-Glass 1 (NoTrim): 36" x 84"	2' - 10"	7'-0"	Main Floor Plan	1
98	Single-Glass I (NoTrim): 34" x 84"		8'-0"	Main Floor Plan	1
105	Overhead-Sectional: 10' x 8'	10'-0"	7' - 0"	Basement Floor Plan	1
106	Single-Flush: 36" x 84"	3-0"	1/30	VUDEREIT TOOL TOOL	J <u>.</u>

		Width	ow Schedule tteight	Head Height	Level	Count
Type Mark	Window Schedule	VVIAITI	1 reigin	1.000	<u> </u>	J
		11 011	6'-0"		Main Floor Plan	2
16	Fixed: 72" x 72"	6'-0"			Training to the same	2
12	Fixed-Triple: 108" x78"	9-0"	6'-6"			2
77	Fixed-Quad: 144" x 78"	12' - 0"	6'-6"		- I - I - DI	1
38	Transom with No Trim: 14'-10" x 18"	14' - 10"	1'-6"	8'-6"	Second Floor Plan	1
30	Transom with No Trim: 13'-4" x 18"	13' - 4"	1'-6"	10' - 6"	Main Floor Plan	1
	Transom with No Trim: 10'-10" x 18"	10' - 10"	1'-6"	8'-6"	Second Floor Plan	1
93		1'-6"	14' - 0"	18'-85/8"	Main Floor Plan	1
102	Casement with NoTrim: 18" x 14"	1'-6"	6'-0"	7'-0"	Main Floor Plan	2
106	Casement with No Trim: 18" x 72"		4-6"	8'-6"	Second Floor Plan	1
107	Transom with NoTrim: 13-6" x 54"	13'-6"		7'-4"	Basement Floor Plan	1
112	Casement-Quad: 144" x 48"	12'-0"	4'-0"		Basement Floor Plan	1
113	Fixed: 36" x 84"	3-0"	7'-0"	7'-4"	Dasement 1 1001 I Idii	1/2
114	Casement with No Trim: 18" x 90"	1'-6"	7'-6"	8'-6"		2
117 117	Transom with NoTrim: 13'-0" x 18"	13'-0"	1'-6"	10' - 6"	Main Floor Plan	1/
Grand total: 18	Transcriving Contracts Contracts					

INUILUI; ~THESE WINDOW AND DOOR SCHEDULES ARE FOR APPROXIMATE SIZE, STYLE, AND LOCATION, THEY MUST BE CONFIRMED BY OWNER/CONTRACTOR. ~SEE WINDOW ICONS ON PLAN VIEWS, REFER TO SCHEDULE FOR SIZE AND HEAD HEIGHT. IF IT DOES NOT APPEAR ON PLAN VIEW, SEE ELEVATION VIEWS FOR LOCATION.

	155UE	DATE	BY	DESCRIPTION
	,	NOV. 27. 2006	JP.	PRELIMINARY DESIGN No. 1
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F	- - - - - - - - - - - - - - - - - - -	Residence
	Basement Floo	or Plan
50 BLACKTA	NL PLACE, 050Y00.	S, BC., (REGAL RIDGE)
SCALE: 1/4" = 1'-0"	DR.	WING No. 5157-05
DRAWN BY : JP	AUG. 02, 2006	A 10 of 11
LOCATION: LOT 8, PLI	W KAP78794, DL 2	109,5DYD

